March 24, 2023

Fax (716) 439-6605

Megan Brewer

REGULAR MEETING

Please be advised that there are two (2) items on the agenda for the regularly scheduled meeting of the Planning Board to be held **Monday**, **April 3**, **2023** at 5:00 P.M.

- 1. Scott Geise. 2 Pine Street. Request for exterior façade upgrades situated in a B-2 Zone.
- 2. Apex Consulting Survey & Engineering Services, PC. 3 Locust Street. Request to install new awnings on the south side of the building for Sub Delicious situated in an B-2 Zone.

If you cannot attend this meeting, please contact Megan Brewer at 716-439-6754 or mbrewer@lockportny.gov



March 20, 2023

Todd M. Retell, D.D.S. James M. Shaw, D.D.S. William L. Langton, D.D.S.

> 39 Elizabeth Drive Lockport, NY 14094 t: 716.433.6004 f: 716.433.7547

Geise Properties LLC gives Tim Arlington, of Apex Consulting, permission to represent Geise Properties LLC for our grant proposal.

Dr. Todd M. Retell DDS

	Ÿ	

APPLICATION: APPROVED DISAPPROVED
CITY OF LOCKPORT PLANNING BOARD APPLICATION
DESCRIPTION OF PROPOSED REQUEST:
NAME OF PROPERTY: Old City Hall PHONE: (716) 863-698
NAME OF PROPERTY: Old City Hall PHONE: (716) 863-698 NAME OF APPLICANT: Scott Geise PHONE: Same
ADDRESS OR LOCATION OF PROPOSAL: 2 Pine Stree!
(P) (A) A-
EXISTING ZONING: Business B2
EXISTING ZONING: Business B2 PROPOSED REQUEST Exterior Building Repair &
Improvement Project
REQUIRED ENCLOSURES:
In order to provide the City Planning Board with adequate information on which to base its decision, this application will not be heard unless the following information is submitted ten (10) days prior to the meeting by no later than 1 p.m.
1. Adequate description of proposal.
2. Survey of property affected, together with a Plot Plan which shows the distance to nearest intersection, proposed physical layout of the property including any existing or proposed structures, traffic access patterns, parking arrangements, walls, fences or other buffers and signs.
SEQRA:
This proposal constitutes a: () Type I, () Type II, () Unlisted action as per the provisions of the State Environmental Quality Review Act. A determination of environmental significance has been made: () yes, () no; a copy of this determination is attached () yes, () no.

APPLICANT'S SIGNATURE

PLEASE NOTE YOU OR A REPRESENTATIVE ARE TO BE PRESENT
AT THE MEETING TO PRESENT YOUR PROJECT TO THE BOARD.

PROPERTY OWNER'S SIGNATURE

		8

Office: (716) 439-0188 • Fax: (716) 439-0189

TIMOTHY W. ARLINGTON, President

SCOPE OF WORK

Scott Geise and Adrienne Kuzma
Stooges Bar & Restaurant
2 Pine Street
City of Lockport
February 2023
Apex No. 20-079

- 1. Scott Geise Building Owner
 - Project
 - a) Restore original copper Yankee Gutters:
 - Remove existing shingles and roof deck back 6"-8" to direct roof drainage to gutters – 60 feet total
 - Install matching shingles 50 Year warranty
 - Seal gutters with waterproof lining
 - Install two new downconductors
 - b) Entrance Roof Replacement:
 - Remove existing metal roof to deck
 - Install (3) 4x8 sheets of ½" sheathing
 - Install Ice and Water Shield, drip edge, shingles 50 year warrant to match existing
 - Install new masonry flashing and vent pipe boots paint to match roof
 - c) Lower Level Overhead Door Replacement:
 - Remove existing wood overhead door
 - Install new 9'x7' steel insulated overhead door with electric door opener
 - d) Exterior Window:
 - Remove and replace existing damaged exterior window on south elevation of building with new double hung unit to match existing windows
 - e) Electrical Repairs:
 - Install new 42 space electrical sub-panel and five new LED light fixtures in lower level of building
 - Furnish and install 10 LED wall wash wall pack lights on exterior of building for aesthetics
 - f) Plumbing Repairs:
 - Furnish and supply a Simplex grinder pump unit for lower level waste water sewage

- Clean out and repair existing trench drain at lower level entrance
- 2. Adrienne Kuzma Stooges Bar and Restaurant Project
 - a) New Bar:
 - Furnish and install new wood framed bar and countertop per attached detail
 - Relocate existing electric power and plumbing as necessary for new bar location and configuration
 - Secure required Building and Plumbing Permits from the City of Lockport
 - b) Ceiling Repair:
 - · Repair existing damaged dry wall ceiling in area of new bar
 - Prime and paint repaired ceiling with minimum two coats of primer/finish latex enamel paint coats

617.20 Appendix B Short Environmental Assessment Form

Instructions for Completing

Part 1 - Project Information. The applicant or project sponsor is responsible for the completion of Part 1. Responses become part of the application for approval or funding, are subject to public review, and may be subject to further verification. Complete Part 1 based on information currently available. If additional research or investigation would be needed to fully respond to any item, please answer as thoroughly as possible based on current information.

Complete all items in Part 1. You may also provide any additional information which you believe will be needed by or useful to the lead agency; attach additional pages as necessary to supplement any item.


Part 1 - Project and Sponsor Information		
-	83	
Name of Action or Project:	6 6	1 , /
Exterior Repairs & Improvements Project Location (describe, and attach a location map):	to Old City 1	tall
Project Location (describe, and attach a location map):	7	
2 Pine Street City of Loc	Kport	
Brief Description of Proposed Action:		
· Restaration of You kee Gutters	0 -	177-74
material to,50 year Asphilt.	Day From Cup. Shingle Color to	oper omatch
Restaration of for Lee Galler. Replace Poof over entrances Material to 50 year As phalt. Mainouilding year As phalt. Peplace overhead Door all Furnish and install 8-9 as	Groken Window Djustable LED Boker	ion Lights
Name of Applicant or Sponsor:	Telephone: (716) 863	-6980
Scott Geise	E-Mail: drscottge	ise@amailoum
Address: 2 Pine Street	·	J
City/PO:	State:	Zip Code; /2/094
1. Does the proposed action only involve the legislative adoption of a plan, l	ocal law, ordinance,	NO YES
administrative rule, or regulation? If Yes, attach a narrative description of the intent of the proposed action and may be affected in the municipality and proceed to Part 2. If no, continue to		hat hat
2. Does the proposed action require a permit, approval or funding from any	other governmental Agency?	NO YES
If Yes, list agency(s) name and permit or approval: City of Lock port Planning Boa	nd	
3.a. Total acreage of the site of the proposed action?	O. 10 acres	
b. Total acreage to be physically disturbed?	acres	
c. Total acreage (project site and any contiguous properties) owned or controlled by the applicant or project sponsor?	C, 10 acres	
4. Check all land uses that occur on, adjoining and near the proposed action		
☑ Urban ☐ Rural (non-agriculture) ☐ Industrial ☑ Comm	a service control	ban)
Forest Agriculture Aquatic Other	(specify):	
□Parkland		

5. Is the proposed action, a. A permitted use under the zoning regulations?	NO	YES,	N/A
	\blacksquare	Ľ,	느
b. Consistent with the adopted comprehensive plan?	Ш	<u> </u>	MEG
6. Is the proposed action consistent with the predominant character of the existing built or natural landscape?		NO	YES
7. Is the site of the proposed action located in, or does it adjoin, a state listed Critical Environmental Area	2	NO	YES
If Yes, identify:	a:	NO I	
8. a. Will the proposed action result in a substantial increase in traffic above present levels?		NO	YES
		$ oxed{ } $	Ш,
b. Are public transportation service(s) available at or near the site of the proposed action?			W,
c. Are any pedestrian accommodations or bicycle routes available on or near site of the proposed action	on?		V
9. Does the proposed action meet or exceed the state energy code requirements?		NO	YES
If the proposed action will exceed requirements, describe design features and technologies:			
3			
10. Will the proposed action connect to an existing public/private water supply?		NO	YES
If No, describe method for providing potable water: Existing Service			П
If No, describe method for providing potable water: Existing Service		<u></u>	
11. Will the proposed action connect to existing wastewater utilities?		NO	YES
If No, describe method for providing wastewater treatment: = xi sting Service			
to be retained	_		<u>.</u>
12. a. Does the site contain a structure that is listed on either the State or National Register of Historic		NO	YES
Places?			V
b. Is the proposed action located in an archeological sensitive area?		V	П
13. a. Does any portion of the site of the proposed action, or lands adjoining the proposed action, contain		NO	YES
wetlands or other waterbodies regulated by a federal, state or local agency?			M
b. Would the proposed action physically alter, or encroach into, any existing wetland or waterbody?		V	
If Yes, identify the wetland or waterbody and extent of alterations in square feet or acres:		163	1 5
14. Identify the typical habitat types that occur on, or are likely to be found on the project site. Check al	l that	apply:	ļ
☐ Shoreline ☐ Forest ☐ Agricultural/grasslands ☐ Early mid-successio	nal		
☐ Wetland Ûrban ☐ Suburban			
15. Does the site of the proposed action contain any species of animal, or associated habitats, listed		NO	YES
by the State or Federal government as threatened or endangered?		V	
16. Is the project site located in the 100 year flood plain?		NO	YES
17 Will the second of the second of the first second of the second of th		NO	VEC
17. Will the proposed action create storm water discharge, either from point or non-point sources? If Yes,		NO	YES
a. Will storm water discharges flow to adjacent properties?			Ш
b. Will storm water discharges be directed to established conveyance systems (runoff and storm drains	s)?		
If Yes, briefly describe:	,	10.1	

18. Does the proposed action include construction or other activities that result in the impowater or other liquids (e.g. retention pond, waste lagoon, dam)?	oundment of	N	0	YES
If Yes, explain purpose and size:		_ _		
		_ L	4	
19. Has the site of the proposed action or an adjoining property been the location of an act	ive or closed	N	0	YES
solid waste management facility? If Yes, describe:		_ [<u> </u>	
20. Has the site of the proposed action or an adjoining property been the subject of remedi completed) for hazardous waste? If Yes, describe:	, ,	or N	0	YES
			<u>~</u>] !	
AFFIRM THAT THE INFORMATION PROVIDED ABOVE IS TRUE AND ACCE KNOWLEDGE Appear Census Iting, Survey & Engineering Applicant/sponsor name: Limsty W. Alington, PE Signature: Timothy W. Alington, PE	: 3/17	120	23	
	d by the project see guided by the			ving my
	e guided by the	o, or nall ipact	Mode to la imp m:	erate
responses been reasonable considering the scale and context of the proposed action?"	e guided by the No sn im m oc	o, or nall	"Have Mode to la imp	erate
responses been reasonable considering the scale and context of the proposed action?" 1. Will the proposed action create a material conflict with an adopted land use plan or zerogulations?	e guided by the No sn im m oc	o, or nall ipact	Mode to la imp m:	erate
1. Will the proposed action create a material conflict with an adopted land use plan or zeregulations? 2. Will the proposed action result in a change in the use or intensity of use of land?	e guided by the No sn im m oc	o, or nall ipact	Mode to la imp m:	erate
1. Will the proposed action create a material conflict with an adopted land use plan or zerogulations? 2. Will the proposed action result in a change in the use or intensity of use of land? 3. Will the proposed action impair the character or quality of the existing community?	e guided by the No sn im m oc oning	o, or nall ipact	Mode to la imp m:	erate
1. Will the proposed action create a material conflict with an adopted land use plan or zeregulations? 2. Will the proposed action result in a change in the use or intensity of use of land? 3. Will the proposed action impair the character or quality of the existing community? 4. Will the proposed action have an impact on the environmental characteristics that cau establishment of a Critical Environmental Area (CEA)?	e guided by the No sn im m oc oning	o, or nall ipact	Mode to la imp m:	erate
1. Will the proposed action create a material conflict with an adopted land use plan or zeregulations? 2. Will the proposed action result in a change in the use or intensity of use of land? 3. Will the proposed action impair the character or quality of the existing community? 4. Will the proposed action have an impact on the environmental characteristics that cau establishment of a Critical Environmental Area (CEA)? 5. Will the proposed action result in an adverse change in the existing level of traffic or affect existing infrastructure for mass transit, biking or walkway?	e guided by the No sn im mood oning	o, or nall ipact	Mode to la imp m:	erate
1. Will the proposed action create a material conflict with an adopted land use plan or zeregulations? 2. Will the proposed action result in a change in the use or intensity of use of land? 3. Will the proposed action impair the character or quality of the existing community? 4. Will the proposed action have an impact on the environmental characteristics that cau establishment of a Critical Environmental Area (CEA)? 5. Will the proposed action result in an adverse change in the existing level of traffic or affect existing infrastructure for mass transit, biking or walkway? 6. Will the proposed action cause an increase in the use of energy and it fails to incorpo reasonably available energy conservation or renewable energy opportunities?	e guided by the No sn im mood oning	o, or nall ipact	Mode to la imp m:	erate
 Will the proposed action create a material conflict with an adopted land use plan or zeregulations? Will the proposed action result in a change in the use or intensity of use of land? Will the proposed action impair the character or quality of the existing community? Will the proposed action have an impact on the environmental characteristics that cau establishment of a Critical Environmental Area (CEA)? Will the proposed action result in an adverse change in the existing level of traffic or affect existing infrastructure for mass transit, biking or walkway? Will the proposed action cause an increase in the use of energy and it fails to incorporeasonably available energy conservation or renewable energy opportunities? Will the proposed action impact existing: 	e guided by the No sn im mood oning	o, or nall ipact	Mode to la imp m:	erate
regulations? 2. Will the proposed action result in a change in the use or intensity of use of land? 3. Will the proposed action impair the character or quality of the existing community? 4. Will the proposed action have an impact on the environmental characteristics that cau establishment of a Critical Environmental Area (CEA)? 5. Will the proposed action result in an adverse change in the existing level of traffic or affect existing infrastructure for mass transit, biking or walkway? 6. Will the proposed action cause an increase in the use of energy and it fails to incorpo reasonably available energy conservation or renewable energy opportunities? 7. Will the proposed action impact existing: a. public / private water supplies?	e guided by the No sn im m oc oning ssed the strate	o, or nall ipact	Mode to la imp m:	erate

	No, or small impact may occur	Moderate to large impact may occur
10. Will the proposed action result in an increase in the potential for erosion, flooding or drain problems?	nage	
11. Will the proposed action create a hazard to environmental resources or human health?		
element of the proposed action may or will not result in a significant adverse environmental im		
Part 3 should, in sufficient detail, identify the impact, including any measures or design elemen he project sponsor to avoid or reduce impacts. Part 3 should also explain how the lead agency may or will not be significant. Each potential impact should be assessed considering its setting, duration, irreversibility, geographic scope and magnitude. Also consider the potential for short	nts that have been determined that probability of o	included by the impact ccurring,
Part 3 should, in sufficient detail, identify the impact, including any measures or design elementhe project sponsor to avoid or reduce impacts. Part 3 should also explain how the lead agency may or will not be significant. Each potential impact should be assessed considering its setting, duration, irreversibility, geographic scope and magnitude. Also consider the potential for short numulative impacts.	nts that have been determined that probability of o	included by the impact ccurring,

Check this box if you have determined, based on the information and analysis above, and any supporting documenta that the proposed action may result in one or more potentially large or significant adverse impacts and an environmental impact statement is required. Check this box if you have determined, based on the information and analysis above, and any supporting documenta that the proposed action will not result in any significant adverse environmental impacts.				
Name of Lead Agency	Date			
Print or Type Name of Responsible Officer in Lead Agency	Title of Responsible Officer			
Signature of Responsible Officer in Lead Agency	Signature of Preparer (if different from Responsible Officer)			

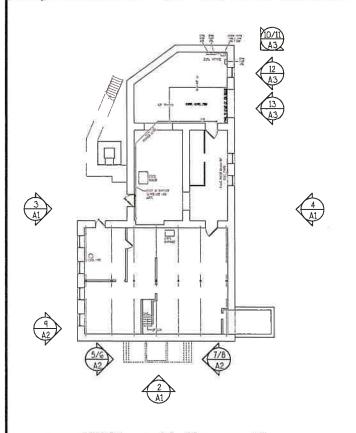




2 WEST ELEVATION



Basement Level Key Plan

SCALE: 1/32" = 1'-0"



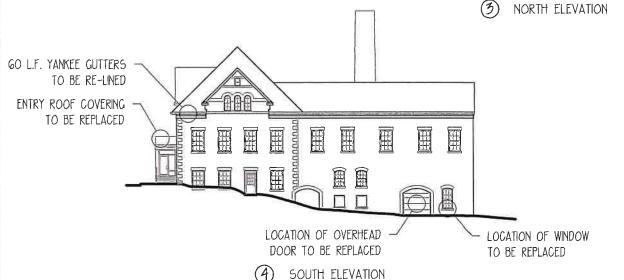

APEX CONSULTING SURVEY & ENGINEERING SERVICES, P.C.

102 EAST AVENUE, LOCKPORT, NEW YORK 14094 Phone: (716) 439-0188 FAX: (716) 439-0189

PREPARED FOR:

SCOTT GEISE / TODO RETELL OLD CITY HALL, 2 PINE STREET LOCKPORT, NY 14094 DRAWING TITLE:

EXISTING CONDITIONS

PROJECT TITLE:

RENOVATION PROJECT

OLD CITY HALL, 2 PINE STREET LOCKPORT, NY 14094

DRAWN:

DATE:

PROJECT NO.: 23-028 DWG. NO.:


SCALE: N.T.S. DWG. _1_

SME

03/21/23

A1DWG. <u>1</u> OF <u>7</u>


e
1

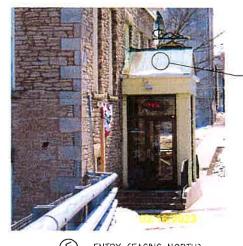

ENTRY ROOF —
COVERING TO
BE REPLACED
W/ SHINGLES
TO MATCH MAIN
BUILDING ROOF.
SEE
SPECIFICATIONS,
DWG. A7 +
FLASHING DETAIL
9/A2.




(6) ENTRY ROOF (FACING NORTH)

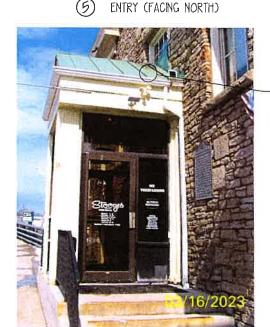

ENTRY ROOF
COVERING TO
BE REPLACED
W/ SHINGLES
TO MATCH MAIN
BUILDING ROOF.
SEE
SPECIFICATIONS,
DWG. A7 +
FLASHING DETAIL
9/A2.



(8) ENTRY ROOF (FACING SOUTH)

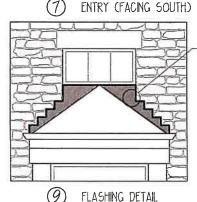

- EXISTING COPPER
FLASHING TO BE
REPLACED WITH ICE +
WATER SHIELD.
CONTINUOUS FROM NEW
ROOF COVERING
INSTALLATION. SHINGLES
TO MATCH EXISTING
ROOF.



(O) YANKEE GUTTER

APEX CONSULTING SURVEY & ENGINEERING SERVICES, P.C.

102 EAST AVENUE, LOCKPORT, NEW YORK 14094 Phone: (716) 439-0188 FAX: (716) 439-0189

PREPARED FOR:

SCOTT GEISE / TODD RETELL OLD CITY HALL, 2 PINE STREET LOCKPORT, NY 14094 DRAWING TITLE:

EXISTING CONDITIONS

PROJECT TITLE:

SME

RENOVATION PROJECT

OLD CITY HALL, 2 PINE STREET LOCKPORT, NY 14094


DRAWN:

DATE:


03/21/23

PROJECT NO.: 23-028 SCALE: N.T.S. DWG, NO.:


DWG. 2 OF 7

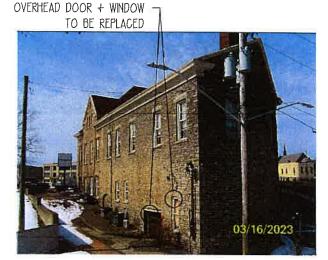

(O) SOUTH ELEVATION

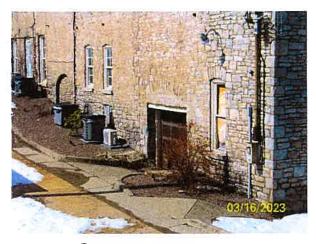


OVERHEAD DOOR + WINDOW TO BE REPLACED (SOUTH **ELEVATION**

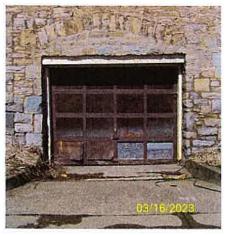

OVERHEAD DOOR TO BE REPLACED



WINDOW TO BE REPLACED

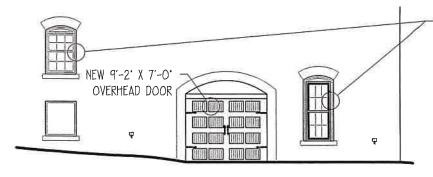

NEW REPLACEMENT WINDOW (32' x 78.5') TO MATCH STYLE OF EXISTING

*NOTE: SEE DRAWING AG FOR OVERHEAD DOOR + WINDOW **SPECIFICATIONS**

(14) PROPOSED WINDOW + OVERHEAD DOOR



102 EAST AVENUE, LOCKPORT, NEW YORK 14094 Phone: (716) 439-0188 FAX: (716) 439-0189

PREPARED FOR:

SCOTT GEISE / TODD RETELL OLD CITY HALL, 2 PINE STREET LOCKPORT, NY 14094

DRAWING TITLE:

EXISTING CONDITIONS / PROPOSED

PROJECT TITLE:


RENOVATION PROJECT

OLD CITY HALL, 2 PINE STREET LOCKPORT, NY 14094

DRAWN:

DATE: PROJECT NO .: DWG. NO.: 23-028 SME 03/21/23 SCALE: N.T.S. DWG. 3 OF

	ж

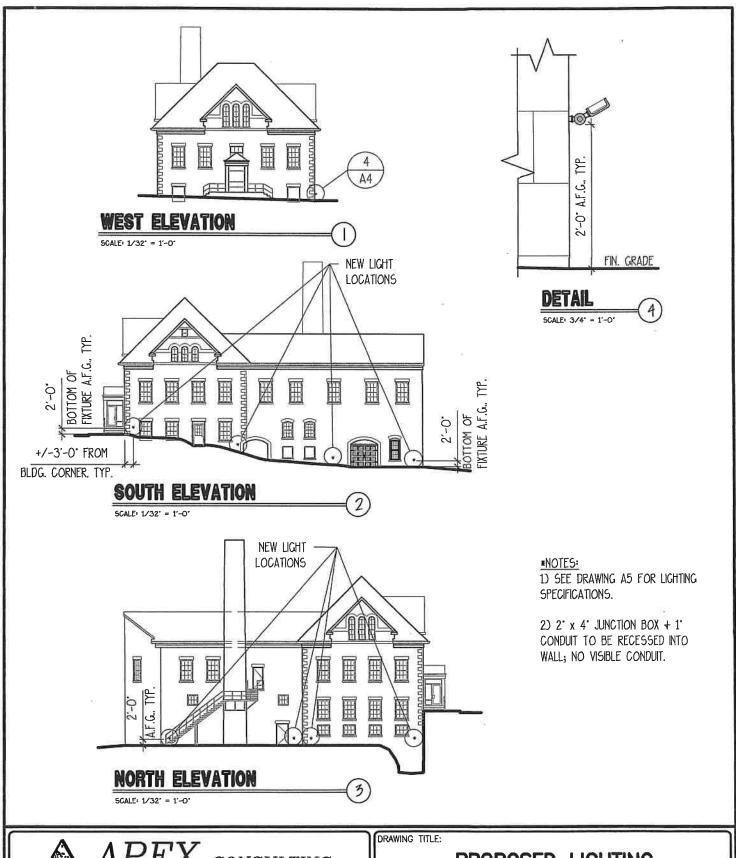



102 EAST AVENUE, LOCKPORT, NEW YORK 14094 Phone: (716) 439-0188 FAX: (716) 439-0189

PREPARED FOR:

SCOTT GEISE / TODD RETELL OLD CITY HALL, 2 PINE STREET LOCKPORT, NY 14094

PROPOSED LIGHTING

PROJECT TITLE:

SME

RENOVATION PROJECT

OLD CITY HALL, 2 PINE STREET LOCKPORT, NY 14094

DRAWN:

03/21/23

DATE:

PROJECT NO.: 23-028 SCALE: N.T.S DWG. NO.:

DWG. 4 OF 7



MORRIS #: 71531B LED SMALL FLOOD - BRONZE **CCT TUNABLE**

120-277V, 15W, 3000-5000K









Features:

- Color Tunable: 3000K, 4000K, 5000K
- Input Voltage: 120-277VAC
- Corrosion Resistant Die Cast Aluminum Housing
- Transparent PC Lens
- **Bronze Housing**
- On/Off Photocontrol included
- Operating Temperature: -40°F to 113°F



- Mount: 1/2" Knuckle installed with Yoke Mount included in box
- IP65 Wet Location Rated
- 50,000+ Hour LED Life Expectancy
- Listings: cULus

0-10V Dimmable

- DLC PRODUCT ID#: S-CR1HDI
- 5 Year Warranty

Part# W	Vattage	Voltage	Lumens	сст	CRI	Dimming	Light Pattern	Lümens/ Watt	DLC PROE	OUCT ID#:
71531B	15W	120-277V	2,130@4K	3K;4K;5K	>70	0-10V	7H7V	142	S-CR1HD	1
								LUMEN OUTPUT	- PESSALIY	VI
									CCT	
		1	5W/30W			77		3000K	4000K	5000K
						WATTS	13	1950	2130	206





DIP Switch for CCT & Photocell

LIGHTING SPECS

SCALE: NOT TO SCALE

Technical Specificaons:

Electrical:

Input Voltage: 120 thru 277 Current: .46A @ 120V Frequency: 50/60Hz Power Factor: ≥.0.93 THD: >20% @ 120V

Product Parameters:

15 Watts

Lumens: 1.950@3K, 2.130@K, 2060@5K Efficacy: 142 Lumens Per Watt 50,000+ L70 Life Span CCT: 3K (WW); 4K (NW); 5K (CW)

Chromacity Measurements:

Beam Angle: 7H7V CRI: >70 R9: 7

DUV: -0.00012

Component Specifications:

LED: Seoul 2835 Driver: 120-277V 50/60Hz Driver Output Volts: 150V/DC Driver Output Amps: 1.0A 2KV Surge Protection

Dimming:

0-10V

Operating Temperature:

Minimum Starting -40°F - 113°F

Construction:

Housing: Die Cast Aluminum Housing Powder Coated IP Rating: IP65 Wet Location Rated

Lens Malerial: PC

Mounting: 1/2" Knuckle, Yoke

Listings: DLC PRODUCT ID#: S-CR1HDI

Warranty:

Morris Products carries a 5 year warranty from date of purchase against defects in materials workmanship (assuming normal and proper usage).



102 EAST AVENUE, LOCKPORT, NEW YORK 14094 Phone: (716) 439-0188 FAX: (716) 439-0189

PREPARED FOR:

SCOTT GEISE / TOOD RETELL OLD CITY HALL, 2 PINE STREET LOCKPORT, NY 14094

DRAWING TITLE:

PROPOSED LIGHTING SPECS

PROJECT TITLE:

RENOVATION PROJECT

OLD CITY HALL, 2 PINE STREET LOCKPORT, NY 14094

DRAWN:

DATE:

PROJECT NO .: 23-028

SME 03/21/23

N.T.S DWG.

		er Se

Type Name

MATERIALS Series 9000 Double Hung, Slider, Picture All-Welded

Trade Type: WINDOWS Work Type: Replacement Type/Style(s), Size, Color: Double Hung, 101-120, Beige Description: Location rear corner of the building 32 X 78.5 DH 6/6 Classic

MATERIALS 5/8" Classic flat Grids

Description: Accessories window match

MATERIALS 101-120 UI large-window add

Description: Windows

MATERIALS Energy Miser IS or


Description: Energy Saving Options

5 MATERIALS Full Insulated Frame & Sash (9000)

Description: Energy Saving Options

window specs

SCALE: NOT TO SCALE

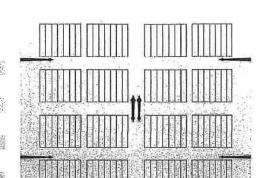

MARKET STATE OF THE STATE OF TH Width: 9' 2" X Height: 7' 0"

Timeless: Stamped Carriage House

Short Panel

PREPARED FOR:

Figural templements/Constitution

inaums (1996)

R-9.65 / 2", Medium Duty, 2-Sided Steel Sandwich, Polystyrene Insulation - 1-13/16" Thick

Control of the contro

Solid Colors: Almond	Qty	Size	Description
Position: NO WINDOWS Window Inserts: No Inserts	1	9'2" x 7'	Door Color: Almond CHI Model 5283 Stamped Short Panel, 27 Gauge Steel Carriage House Sandwich Door, 2" Thick Sections, 1-13/18" Polystyrene Insulation Bonded to Interior & Exterior Steel Skins, 2" Track, Torsion Spring(s), White Nylon
Standard Decorative Spade Handles And Hinges	1 1 1		Rollers, 1 Set (4 Hinges/2 Handles) Black stamped Decorative Hardware, Installed 15" Radius Standard Lift Track Reverse Angle Track Mount to Steel Reverse Angle Weather Seal-Top Seal & Side Seal
SCALE: NOT TO SCALE	1		Liftmaster Model 8500W DC Battery Backup Wall Mount garage door opener, Built-in WI-FI, MyQ remote LED light, Autoamatic Garage Door Lock, Smart control Wall Panel 880LM, 2 Remotes, 1 Wireless Keypad, Installed



102 EAST AVENUE, LOCKPORT, NEW YORK 14094 Phone: (716) 439-0188 FAX: (716) 439-0189

SCOTT	GEISE /	TODD	RETELL
OLD CI	TV HALL	2 DINE	CTDEET

OLD CITY HALL, 2 PINE STF LOCKPORT, NY 14094

DRAWING TITLE:

PROPOSED WINDOW/OHD SPECS

PROJECT TITLE:

RENOVATION PROJECT

OLD CITY HALL, 2 PINE STREET LOCKPORT, NY 14094

DRAWN:

DATE:

PROJECT NO .: 23-028 DWG. NO .:

A6

SME

03/21/23

SCALE: N.T.S.

		*

Roofing Section

- Protect the house and landscaping with tarps.
- Remove existing metal roof down to roof deck.
- Check and replace decking as needed. Three (3) 4x8 Sheets are included in the contract price.
- Install Ice and Water shield.
- Install new Aluminum ODE Drip Edge on rakes and eaves.
- Install Starter Shingles along the rakes and eaves giving the Shingles a wind rating of 130mph.
- Install GAF Camelot Designer Shingles to roof with six (6) nails per shingle as per manufacturer specs. (50 year)
- Install matching GAF Ridge Shingles.
- -Install new masonry flashing and counter flashing where needed.
- Install new pipe boots. Paint white pipes with color-matched paint.

ENTRY ROOF SPECS

SCALE: NOT TO SCALE

Roofing Eaves along the front building

- Protect the building and landscaping with tarps.
- Remove existing shingles and roof deck back 6"-8" from the front eaves so it dumps into the existing yankee gutters. There are 2 L-Shaped eaves of roughly 30 feet each, 60 feet total.
- Install Starter Shingles along the eaves.
- Install Matching Shingles to roof with six (6) nails per shingle as per manufacturer specs. (50 year)
- Install new Aluminum ODE Drip Edge on eaves.
- Seal the the gutter (internally) and slightly pitch.
- Install 2 downspouts, one per side.

GUTTER SPECS

SCALE: NOT TO SCALE

2



102 EAST AVENUE, LOCKPORT, NEW YORK 14094 Phone: (716) 439-0188 FAX: (716) 439-0189

PREPARED FOR:

SCOTT GEISE / TODD RETELL OLD CITY HALL, 2 PINE STREET LOCKPORT, NY 14094 DRAWING TITLE:

PROPOSED ROOF/GUTTER SPECS

PROJECT TITLE:

RENOVATION PROJECT

OLD CITY HALL, 2 PINE STREET LOCKPORT, NY 14094

DRAWN:

DATE:

PROJECT NO.: 23-028

DWG. NO.:

SME

03/21/23

SCALE: N.T.S.

WG. <u>7</u> OF <u>7</u>

			*1,
	ar		
		T	



KATHY HOCHUL Governor ERIK KULLESEID
Commissioner

March 23, 2023

Heather Peck Vice-President Greater Lockport Development Corporation One Locks Plaza Lockport, NY 14094

Re:

OCR

Old City Hall Renovation/Upgrades 2 Pine St, Lockport, NY 14094

23PR01708

Dear Heather Peck:

Thank you for continuing to consult with the New York State Historic Preservation Office (SHPO). We have reviewed the provided documentation in accordance with Section 106 of the National Historic Preservation Act of 1966. These comments are those of the SHPO and relate only to Historic/Cultural resources.

Our office has reviewed the requested information, which includes drawings with photos dated 3/21/2023 and cut sheets for the proposed rehabilitation work at the State and National Register listed Old Lockport City Hall. Based upon our review, it is the SHPO's opinion that this project will have No Adverse Effect on historic resources.

If you have any questions, I am best reached by email.

Sincerely,

Derek Rohde

Historic Site Restoration Coordinator

518-275-5745 | Derek.Rohde@parks.ny.gov

APPLICATION: APPROVED DISAPPROVED
CITY OF LOCKPORT PLANNING BOARD APPLICATION Properties L
DESCRIPTION OF PROPOSED REQUEST:
NAME OF PROPERTY: Thomas Milane and PHONE: (716) 570-361
PLANNING BOARD APPLICATION Properties L DESCRIPTION OF PROPOSED REQUEST: NAME OF PROPERTY: NAME OF PROPERTY: PHONE: (716) 570-3614 NAME OF APPLICANT: PHONE: (716) 439-0188 ADDRESS OR LOCATION OF PROPOSAL: 15 Locust St (C) Lockport
ADDRESS OR LOCATION OF PROPOSAL: 15 Locust St (C) Lockport
SIZE OF PARCEL OR STRUCTURE: See a Hackments of building
EXISTING ZONING: BZ Business
PROPOSED REQUEST Proposed New Building Siznage
and Awnings
REQUIRED ENCLOSURES:
In order to provide the City Planning Board with adequate information on which to base its decision, this application will not be heard unless the following information is submitted ten (10) days prior to the meeting by no later than 1 p.m.
1. Adequate description of proposal.
2. Survey of property affected, together with a Plot Plan which shows the distance to nearest intersection, proposed physical layout of the property including any existing or proposed structures, traffic access patterns, parking arrangements, walls, fences or other buffers and signs.
SEQRA:
This proposal constitutes a: () Type I, Type II, () Unlisted action as per the provisions of the State Environmental Quality Review Act. A determination of environmental significance has been made: (yes, ()no; a copy of this determination is attached (yes, ()no.
PROPERTY OWNER'S SIGNATURE
APPLICANT'S SIGNATURE Tout Island
PLEASE NOTE YOU OR A REPRESENTATIVE ARE TO BE PRESENT AT THE MEETING TO PRESENT YOUR PROJECT TO THE BOARD.

Si R_{ene}

617.20 Appendix B Short Environmental Assessment Form

Instructions for Completing

Part 1 - Project Information. The applicant or project sponsor is responsible for the completion of Part 1. Responses become part of the application for approval or funding, are subject to public review, and may be subject to further verification. Complete Part 1 based on information currently available. If additional research or investigation would be needed to fully respond to any item, please answer as thoroughly as possible based on current information.

Complete all items in Part 1. You may also provide any additional information which you believe will be needed by or useful to the lead agency; attach additional pages as necessary to supplement any item.

Part 1 - Project and Sponsor Information	790 X
Name of Action or Project:	
Sub Delicions Sygnage and Awnings Project Location (describe, and attach a location map):	
Project Location (describe, and attach a location map):	8 "
15 Locust St. City of Lockport	E 20
Brief Description of Proposed Action:	
Brief Description of Proposed Action: (1) Replace Brisking Building Sugnage for Sub Delicions Restaurant Delicions Restaurant	
Delicions Restaurant	201 8
Delicions Restaurant (2) Install New Awnings on Sub Delicions Building Elevations	
Elevations	i.e
2 2 2 2 2 2 2 2 2 2 2 2 2 2 2 2 2 2 2	
Name of Applicant or Sponsor: Telephone: (7.6) 439-0198	a
Apex Consulting Survey & Engineering E-Mail: lington @apex consult Address: Services Dk	night ne
Address: Services DE	<i>y</i> .
102 East Ave	
City/PO: State: Zip Code:	
Lockport NY 14094	
1. Does the proposed action only involve the legislative adoption of a plan, local law, ordinance, NO YES	
administrative rule, or regulation? If Yes, attach a narrative description of the intent of the proposed action and the environmental resources that	
may be affected in the municipality and proceed to Part 2. If no, continue to question 2.	
2. Does the proposed action require a permit, approval or funding from any other governmental Agency? NO YES	
If Yes, list agency(s) name and permit or approval: Site Plan Approval (C) Planning Board	
City Building, Permit	
3.a. Total acreage of the site of the proposed action? O 20 acres	
b. Total acreage to be physically disturbed?	
c. Total acreage (project site and any contiguous properties) owned or controlled by the applicant or project sponsor?	
or controlled by the applicant of project sponsor:	
4. Check all land uses that occur on, adjoining and near the proposed action.	
☑ Urban ☐ Rural (non-agriculture) ☐ Industrial ☑ Commercial ☐ Residential (suburban)	
☐ Forest ☐ Agriculture ☐ Aquatic ☐ Other (specify):	
☐ Parkland	

F	NO	YES	N/A
5. Is the proposed action, a. A permitted use under the zoning regulations?	NO	X	
b. Consistent with the adopted comprehensive plan?		X	
6. Is the proposed action consistent with the predominant character of the existing built or natural landscape?	4.2	NO	VES
7. Is the site of the proposed action located in, or does it adjoin, a state listed Critical Environmental Art If Yes, identify:	ea?	NO	YES
			Ш
8. a. Will the proposed action result in a substantial increase in traffic above present levels?	- 10 Lin (4	NO	YES
b. Are public transportation service(s) available at or near the site of the proposed action?			X
c. Are any pedestrian accommodations or bicycle routes available on or near site of the proposed act	ion?		X
9. Does the proposed action meet or exceed the state energy code requirements? If the proposed action will exceed requirements, describe design features and technologies:	(i):	NO X	YES
10. Will the proposed action connect to an existing public/private water supply?	===	NO	YES
If No, describe method for providing potable water:		\boxtimes	
11. Will the proposed action connect to existing wastewater utilities?		NO	YES
If No, describe method for providing wastewater treatment:			
12. a. Does the site contain a structure that is listed on either the State or National Register of Historic Places?		NO X	YES
b. Is the proposed action located in an archeological sensitive area?		X	
13. a. Does any portion of the site of the proposed action, or lands adjoining the proposed action, contain wetlands or other waterbodies regulated by a federal, state or local agency?	n	NO T	YES
b. Would the proposed action physically alter, or encroach into, any existing wetland or waterbody? If Yes, identify the wetland or waterbody and extent of alterations in square feet or acres:		X	
14. Identify the typical habitat types that occur on, or are likely to be found on the project site. Check a ☐ Shoreline ☐ Forest ☐ Agricultural/grasslands ☐ Early mid-successi ☐ Wetland ☐ Suburban	ll that onal	apply:	1.S. Ugur on Co
☐ Wetland ☐ Suburban ☐ Suburban 15. Does the site of the proposed action contain any species of animal, or associated habitats, listed		NO	YES
by the State or Federal government as threatened or endangered?		X	
16. Is the project site located in the 100 year flood plain?		NO X	YES
17. Will the proposed action create storm water discharge, either from point or non-point sources? If Yes,		NO	YES
a. Will storm water discharges flow to adjacent properties? □ NO □ YES		X	
b. Will storm water discharges be directed to established conveyance systems (runoff and storm drain If Yes, briefly describe: ☐ NO ☐ YES	ıs)?		
The state of the s		7 E 18	

18. Does the proposed action include construction or other activities that result in the impoundment of	-	NO	YES
water or other liquids (e.g. retention pond, waste lagoon, dam)?	===	+11-	_=
If Yes, explain purpose and size:		M	
	r		N== 3
19. Has the site of the proposed action or an adjoining property been the location of an active or close	d	NO	YES
solid waste management facility?			
If Yes, describe:		V	
			<u> </u>
teles to the second compare and a second regard of special and second second on a second second second second second		Maria 440	(C. 2044)
20. Has the site of the proposed action or an adjoining property been the subject of remediation (ongo completed) for hazardous waste?	ing or	NO	YES
If Yes, describe:			
		\triangle	Ш
AFFIRM THAT THE INFORMATION PROVIDED ABOVE IS TRUE AND ACCURATE T	OTHE B	EST O	EMY
Applicant/sponsor name: Tomosty W. Arlungton to Date: 3/	200	12	02:
Signatures 1	-/		
Signature: 10mmy 10 - On 10 - 10	9		
questions in Part 2 using the information contained in Part 1 and other materials submitted by the proj otherwise available to the reviewer. When answering the questions the reviewershould be guided by	the conce	ргтпа	ve my
Part 2 - Impact Assessment. The Lead Agency is responsible for the completion of Part 2. Answ questions in Part 2 using the information contained in Part 1 and other materials submitted by the project otherwise available to the reviewer. When answering the questions the reviewer should be guided by responses been reasonable considering the scale and context of the proposed action?"			
questions in Part 2 using the information contained in Part 1 and other materials submitted by the proj otherwise available to the reviewer. When answering the questions the reviewershould be guided by	No, or	Mo	derate
questions in Part 2 using the information contained in Part 1 and other materials submitted by the projotherwise available to the reviewer. When answering the questions the reviewershould be guided by		Mo to	derate large
questions in Part 2 using the information contained in Part 1 and other materials submitted by the proj otherwise available to the reviewer. When answering the questions the reviewershould be guided by	No, or	Mo to in	derate large
questions in Part 2 using the information contained in Part 1 and other materials submitted by the project the reviewer. When answering the questions the reviewer should be guided by responses been reasonable considering the scale and context of the proposed action?"	No, or small impact may	Mo to in	derate large apact may
questions in Part 2 using the information contained in Part 1 and other materials submitted by the proportion of the reviewer. When answering the questions the reviewer should be guided by responses been reasonable considering the scale and context of the proposed action?"	No, or small impact may	Mo to in	derate large apact may
questions in Part 2 using the information contained in Part 1 and other materials submitted by the proportion of the reviewer. When answering the questions the reviewer should be guided by responses been reasonable considering the scale and context of the proposed action?" 1. Will the proposed action create a material conflict with an adopted land use plan or zoning regulations?	No, or small impact may	Mo to in	derate large apact may
1. Will the proposed action create a material conflict with an adopted land use plan or zoning regulations? Will the proposed action result in a change in the use or intensity of use of land?	No, or small impact may	Mo to in	derate large apact may
1. Will the proposed action create a material conflict with an adopted land use plan or zoning regulations? 2. Will the proposed action result in a change in the use or intensity of use of land? 3. Will the proposed action impair the character or quality of the existing community?	No, or small impact may	Mo to in	derate large apact may
questions in Part 2 using the information contained in Part 1 and other materials submitted by the project therwise available to the reviewer. When answering the questions the reviewer should be guided by responses been reasonable considering the scale and context of the proposed action?" 1. Will the proposed action create a material conflict with an adopted land use plan or zoning regulations? 2. Will the proposed action result in a change in the use or intensity of use of land? 3. Will the proposed action impair the character or quality of the existing community?	No, or small impact may	Mo to in	derate large apact may
1. Will the proposed action result in a change in the use or intensity of use of land? 2. Will the proposed action result in a change in the use or intensity of use of land? 3. Will the proposed action impair the character or quality of the existing community? 4. Will the proposed action have an impact on the environmental characteristics that caused the establishment of a Critical Environmental Area (CEA)?	No, or small impact may	Mo to in	derate large apact may
1. Will the proposed action create a material conflict with an adopted land use plan or zoning regulations? 2. Will the proposed action result in a change in the use or intensity of use of land? 3. Will the proposed action impair the character or quality of the existing community? 4. Will the proposed action have an impact on the environmental characteristics that caused the establishment of a Critical Environmental Area (CEA)?	No, or small impact may	Mo to in	derate large apact may
nuestions in Part 2 using the information contained in Part 1 and other materials submitted by the proportion of the reviewer. When answering the questions the reviewer should be guided by responses been reasonable considering the scale and context of the proposed action?" 1. Will the proposed action create a material conflict with an adopted land use plan or zoning regulations? 2. Will the proposed action result in a change in the use or intensity of use of land? 3. Will the proposed action impair the character or quality of the existing community? 4. Will the proposed action have an impact on the environmental characteristics that caused the establishment of a Critical Environmental Area (CEA)? 5. Will the proposed action result in an adverse change in the existing level of traffic or affect existing infrastructure for mass transit, biking or walkway? 6. Will the proposed action cause an increase in the use of energy and it fails to incorporate	No, or small impact may	Mo to in	derate large apact may
nuestions in Part 2 using the information contained in Part 1 and other materials submitted by the proportion of the reviewer. When answering the questions the reviewer should be guided by responses been reasonable considering the scale and context of the proposed action?" 1. Will the proposed action create a material conflict with an adopted land use plan or zoning regulations? 2. Will the proposed action result in a change in the use or intensity of use of land? 3. Will the proposed action impair the character or quality of the existing community? 4. Will the proposed action have an impact on the environmental characteristics that caused the establishment of a Critical Environmental Area (CEA)? 5. Will the proposed action result in an adverse change in the existing level of traffic or affect existing infrastructure for mass transit, biking or walkway? 6. Will the proposed action cause an increase in the use of energy and it fails to incorporate reasonably available energy conservation or renewable energy opportunities?	No, or small impact may	Mo to in	derate large apact may
questions in Part 2 using the information contained in Part 1 and other materials submitted by the proportherwise available to the reviewer. When answering the questions the reviewershould be guided by responses been reasonable considering the scale and context of the proposed action?" 1. Will the proposed action create a material conflict with an adopted land use plan or zoning regulations? 2. Will the proposed action result in a change in the use or intensity of use of land? 3. Will the proposed action impair the character or quality of the existing community? 4. Will the proposed action have an impact on the environmental characteristics that caused the establishment of a Critical Environmental Area (CEA)? 5. Will the proposed action result in an adverse change in the existing level of traffic or affect existing infrastructure for mass transit, biking or walkway? 6. Will the proposed action cause an increase in the use of energy and it fails to incorporate reasonably available energy conservation or renewable energy opportunities? 7. Will the proposed action impact existing:	No, or small impact may	Mo to in	derate large apact may
questions in Part 2 using the information contained in Part 1 and other materials submitted by the proportion of the reviewer. When answering the questions the reviewer should be guided by responses been reasonable considering the scale and context of the proposed action?" 1. Will the proposed action create a material conflict with an adopted land use plan or zoning regulations? 2. Will the proposed action result in a change in the use or intensity of use of land? 3. Will the proposed action impair the character or quality of the existing community? 4. Will the proposed action have an impact on the environmental characteristics that caused the establishment of a Critical Environmental Area (CEA)? 5. Will the proposed action result in an adverse change in the existing level of traffic or affect existing infrastructure for mass transit, biking or walkway? 6. Will the proposed action cause an increase in the use of energy and it fails to incorporate reasonably available energy conservation or renewable energy opportunities?	No, or small impact may	Mo to in	derate large apact may
nuestions in Part 2 using the information contained in Part 1 and other materials submitted by the propostherwise available to the reviewer. When answering the questions the reviewer should be guided by responses been reasonable considering the scale and context of the proposed action?" 1. Will the proposed action create a material conflict with an adopted land use plan or zoning regulations? 2. Will the proposed action result in a change in the use or intensity of use of land? 3. Will the proposed action impair the character or quality of the existing community? 4. Will the proposed action have an impact on the environmental characteristics that caused the establishment of a Critical Environmental Area (CEA)? 5. Will the proposed action result in an adverse change in the existing level of traffic or affect existing infrastructure for mass transit, biking or walkway? 6. Will the proposed action cause an increase in the use of energy and it fails to incorporate reasonably available energy conservation or renewable energy opportunities? 7. Will the proposed action impact existing: a. public / private water supplies? b. public / private wastewater treatment utilities? 8. Will the proposed action impair the character or quality of important historic, archaeological,	No, or small impact may	Mo to in	derate large apact may
questions in Part 2 using the information contained in Part 1 and other materials submitted by the propotherwise available to the reviewer. When answering the questions the reviewer should be guided by responses been reasonable considering the scale and context of the proposed action?" 1. Will the proposed action create a material conflict with an adopted land use plan or zoning regulations? 2. Will the proposed action result in a change in the use or intensity of use of land? 3. Will the proposed action impair the character or quality of the existing community? 4. Will the proposed action have an impact on the environmental characteristics that caused the establishment of a Critical Environmental Area (CEA)? 5. Will the proposed action result in an adverse change in the existing level of traffic or affect existing infrastructure for mass transit, biking or walkway? 6. Will the proposed action cause an increase in the use of energy and it fails to incorporate reasonably available energy conservation or renewable energy opportunities? 7. Will the proposed action impact existing: a. public / private water supplies? b. public / private water supplies? b. public / private wastewater treatment utilities? 8. Will the proposed action impair the character or quality of important historic, archaeological, architectural or aesthetic resources?	No, or small impact may	Mo to in	derate large apact may
questions in Part 2 using the information contained in Part 1 and other materials submitted by the propotherwise available to the reviewer. When answering the questions the reviewer should be guided by responses been reasonable considering the scale and context of the proposed action?" 1. Will the proposed action create a material conflict with an adopted land use plan or zoning regulations? 2. Will the proposed action result in a change in the use or intensity of use of land? 3. Will the proposed action impair the character or quality of the existing community? 4. Will the proposed action have an impact on the environmental characteristics that caused the establishment of a Critical Environmental Area (CEA)? 5. Will the proposed action result in an adverse change in the existing level of traffic or affect existing infrastructure for mass transit, biking or walkway? 6. Will the proposed action cause an increase in the use of energy and it fails to incorporate reasonably available energy conservation or renewable energy opportunities? 7. Will the proposed action impact existing: a. public / private wastewater treatment utilities? 8. Will the proposed action impair the character or quality of important historic, archaeological,	No, or small impact may	Mo to in	derate large apact may

	No, or small impact may occur	Moderate to large impact may occur
10. Will the proposed action result in an increase in the potential for erosion, flooding or drainage problems?		
11., Will the proposed action create a hazard to environmental resources or human health?		

Part 3 - Determination of significance. The Lead Agency is responsible for the completion of Part 3. For every question in Part 2 that was answered "moderate to large impact may occur", or if there is a need to explain why a particular element of the proposed action may or will not result in a significant adverse environmental impact, please complete Part 3. Part 3 should, in sufficient detail, identify the impact, including any measures or design elements that have been included by the project sponsor to avoid or reduce impacts. Part 3 should also explain how the lead agency determined that the impact may or will not be significant. Each potential impact should be assessed considering its setting, probability of occurring, duration, irreversibility, geographic scope and magnitude. Also consider the potential for short-term, long-term and cumulative impacts.

that the proposed action may result in one or more pote environmental impact statement is required.	
Check this box if you have determined, based on the info that the proposed action will not result in any significant	rmation and analysis above, and any supporting documentation, adverse environmental impacts.
Name of Lead Agency	Date
	<u> </u>
Print or Type Name of Responsible Officer in Lead Agency	Title of Responsible Officer
Signature of Responsible Officer in Lead Agency	Signature of Preparer (if different from Responsible Officer)

tarlington@apexconsultingpc.net

From:

Heather Peck <hpeck@lockportdevelopment.org>

Sent:

Wednesday, March 22, 2023 12:57 PM

To:

(tarlington@apexconsultingpc.net)

Cc:

Brian Smith (briansmithwny@gmail.com)

Subject:

Fw: Planning board permission application

Tim,

See letter from Milani below.

heather

Heather B. Peck

Vice President Greater Lockport Development Corporation One Locks Plaza Lockport, NY 14094 716-525-0620 hpeck@lockportdevelopment.org

From: Thomas Milani <thomasgmil@icloud.com> Sent: Wednesday, March 22, 2023 12:47 PM

To: Heather Peck <hpeck@lockportdevelopment.org> **Subject:** Re: Planning board permission application

3-22-2023

City of Lockport Planning Board

Dear Sir/Madam,

I am writing to seek permission that Mr Tim Arlington of Apex Consulting of Lockport NY be allowed to complete the necessary application documents as well as appear on behalf of Thomas Milani and SubDelicious as well as my property, located at 5-15 Locust Street Lockport, NY. Thank you in advance for your cooperation.

Yours truly

*	а	

Man Al.

			e e e e e e
		N.	
á			


Showsing 205"

27 - 3"

205"

Delicions

Pizza · Subs · Wings

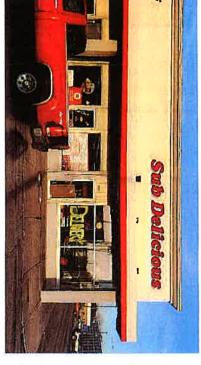







"THIS DESIGN PROPOSAL IS TO REMAIN PROPERTY OF LETICH SIGN CO. UNTLAPPROVED & ACCEPTED THRUPURCHASE BY MAIMED CLENT.

Channel Letters

Client Approval

177 Oakhurst Street Lockport, New York 14094

Phone (716) 434-0167 Fax (716) 434-0226

www.utichsigns.com

Customer

Sub Delicious

ocation

Lockport

18"

Date

2122123

sales Representative

Chris

Designer

A. Boehmer

Sub Delicious Channel Letters File Name

Colors

Black Trim & Returns Red Vinly Faces

Due to differences in monitors and printers, colors you see may vary from final product.

Description

Illuminated Channel Letters




UL inspected and labeled in accordance with UL standard #46 for electric signs installed, using UL listed parts and methods of installation in

cordance with the National

This algo is intended to be installed in accordance with the requirements of Article 600 of the Nathonal Berthal Code and/or other suppleable focal codes. This includes proper grounding and boarding of the eign. Electric Code.

THIS DESIGN PROPOSAL IS
THE EXPRESS PROPERTY
OF ULRICH SIGN CO. UNTIL
APPROVED & ACCEPTED
THROUGH PURCHASE BY NAMED CLENT

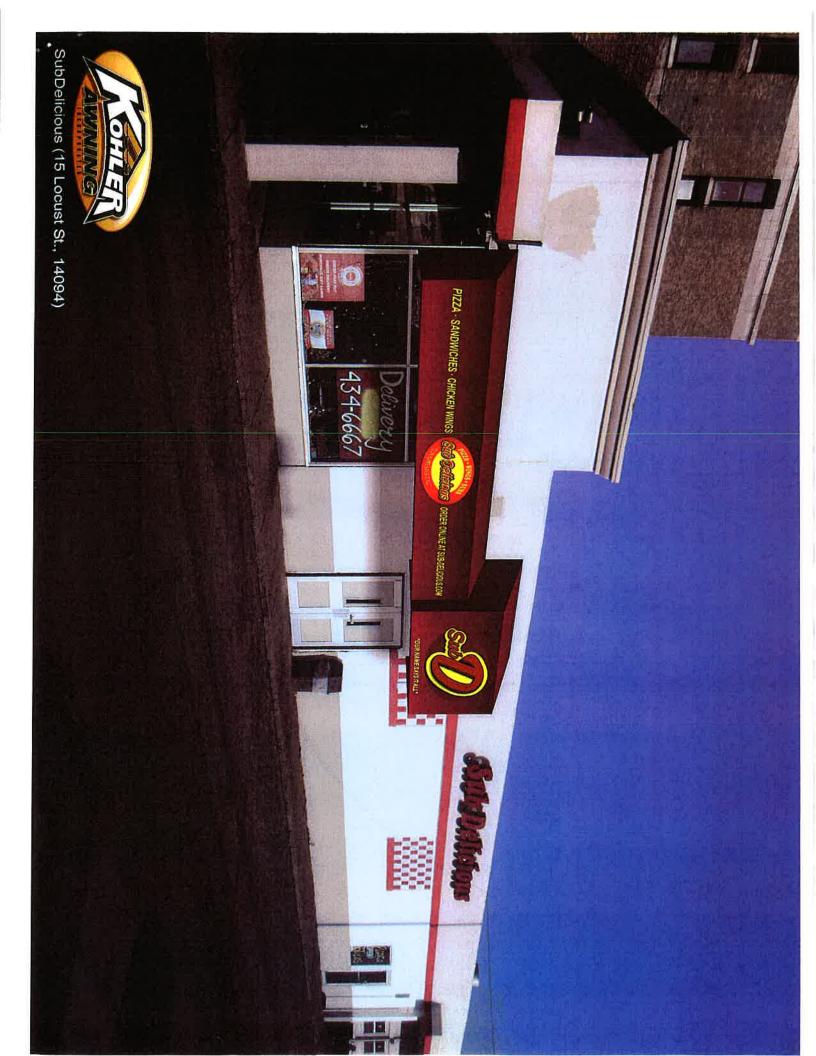

		141,



PIZZA · SANDWICHES · CHICKEN WINGS STOP DELICIOUS, COM 300 in

48 In 34 ln

54 in 72 in 2 8

60 in 48 in

62.9 in

50.9 in :"OUR NAME SAYS IT ALL"

PIZZA · SANDWICHES · CHICKEN WINGS

ORDER ONLINE AT SUB-DELICIOUS.COM

28 in

40 in

ONLY LOGOS LIGHT UP

Salesman: Tom Garrity

Fabric/Substrate(s): Awnmax 6103 Burgundy 1160 Cool White

Graphic Color(s): 7125-015 Bright Yellow and Digital Print

File Name: SubDelicious (15 Locust St., 14094)

Font(s): Arial Bold Italic

RENDERING COLORS MAY NOT BE EXACT REPRESENTATION OF ACTUAL FABRIC, COLOR SWATCHES AVAILABLE UPON REQUEST

Graphic Material(s): 3m Non Translucent Vinyl and Digital Print Rendering #: 01 Date: 03/20/2023 WITH MY SIGNATURE I HEREBY ALLOW KOHLER AWNING TO BEGIN WORK ON THE RENDERING SHOWN HERE. CHOICE#